
LAKE CHELAN TRIBUTARY FISH PASSAGE PRELIMINARY DESIGN

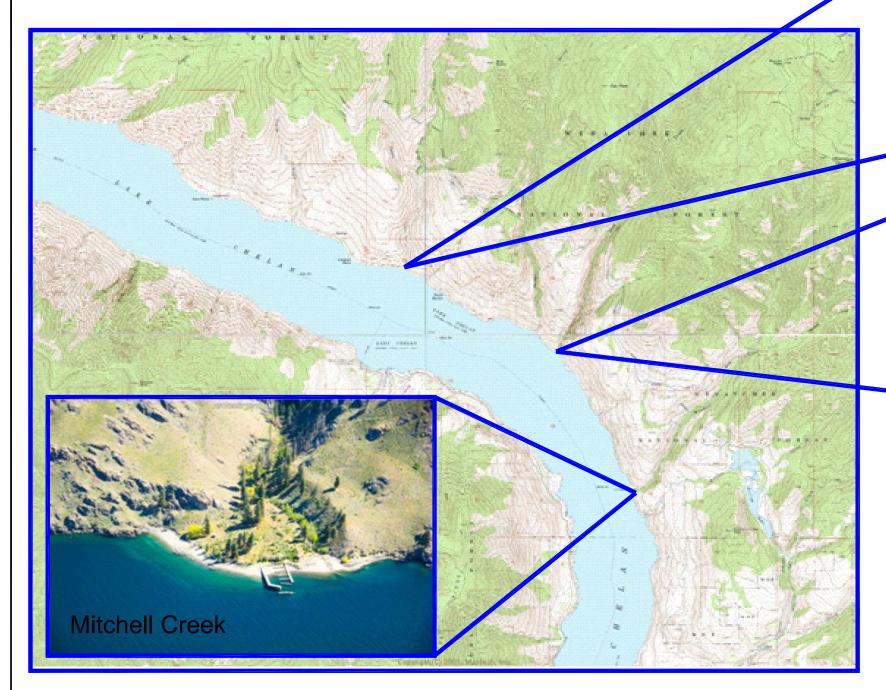





DRAWING INDEX:

- 1. Site Maps
- 2. Drainage Areas
- 3. Mitchell Creek Site Plan
- Mitchel Creek Profile
 Gold Creek Site Plan
- 6. Gold Creek Profile
- 7. Grade Creek Site Plan
- 8. Grade Creek Profile

Consultant Team:

Fairbanks Environmental Services
Waterfall Engineering

Geo Engineers

rade Creeks
ade Creeks
SHEET NO. 1 OF 8
Map






2 and 100 Yr Flow, Fish Passage Design Flows and Channel Width Based on Drainage Area:

	$Q2^{a}$	Q100° Qfpb	Channel Width [°]
Site		(cfs)	(ft)
Mitchel Creek	155	1163 98	12
Gold Creek	222	1650 105	15
Grade Creek	176	1318 142	13

References: a) Sumioka, USGS, 1988 b) Rowland, WSU, 2001

c) Castro,?

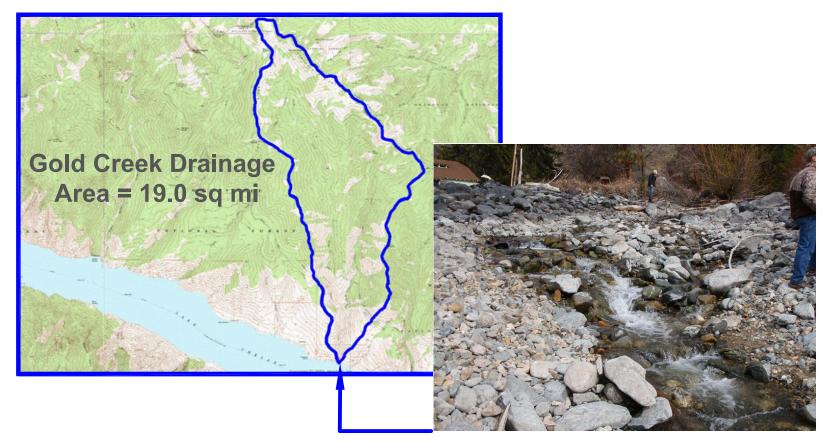


LAKE CHELAN TRIBUTARY FISH PASSAGE


			REVISIONS				
Mitc	Waterfall Engineering	DESIGNED BY:	DESCRIPTION	APP'D	BY	DATE	REV
] IVIICO		DRAWN BY:					
		CHECKED BY:					
		APPROVED BY:					
Ī		FILE.					
	6/22/09	DATE:					
1							


Mitchell, Gold and Grade Creeks


Drainage Areas and Photos

SHEET NO. 2 OF 8

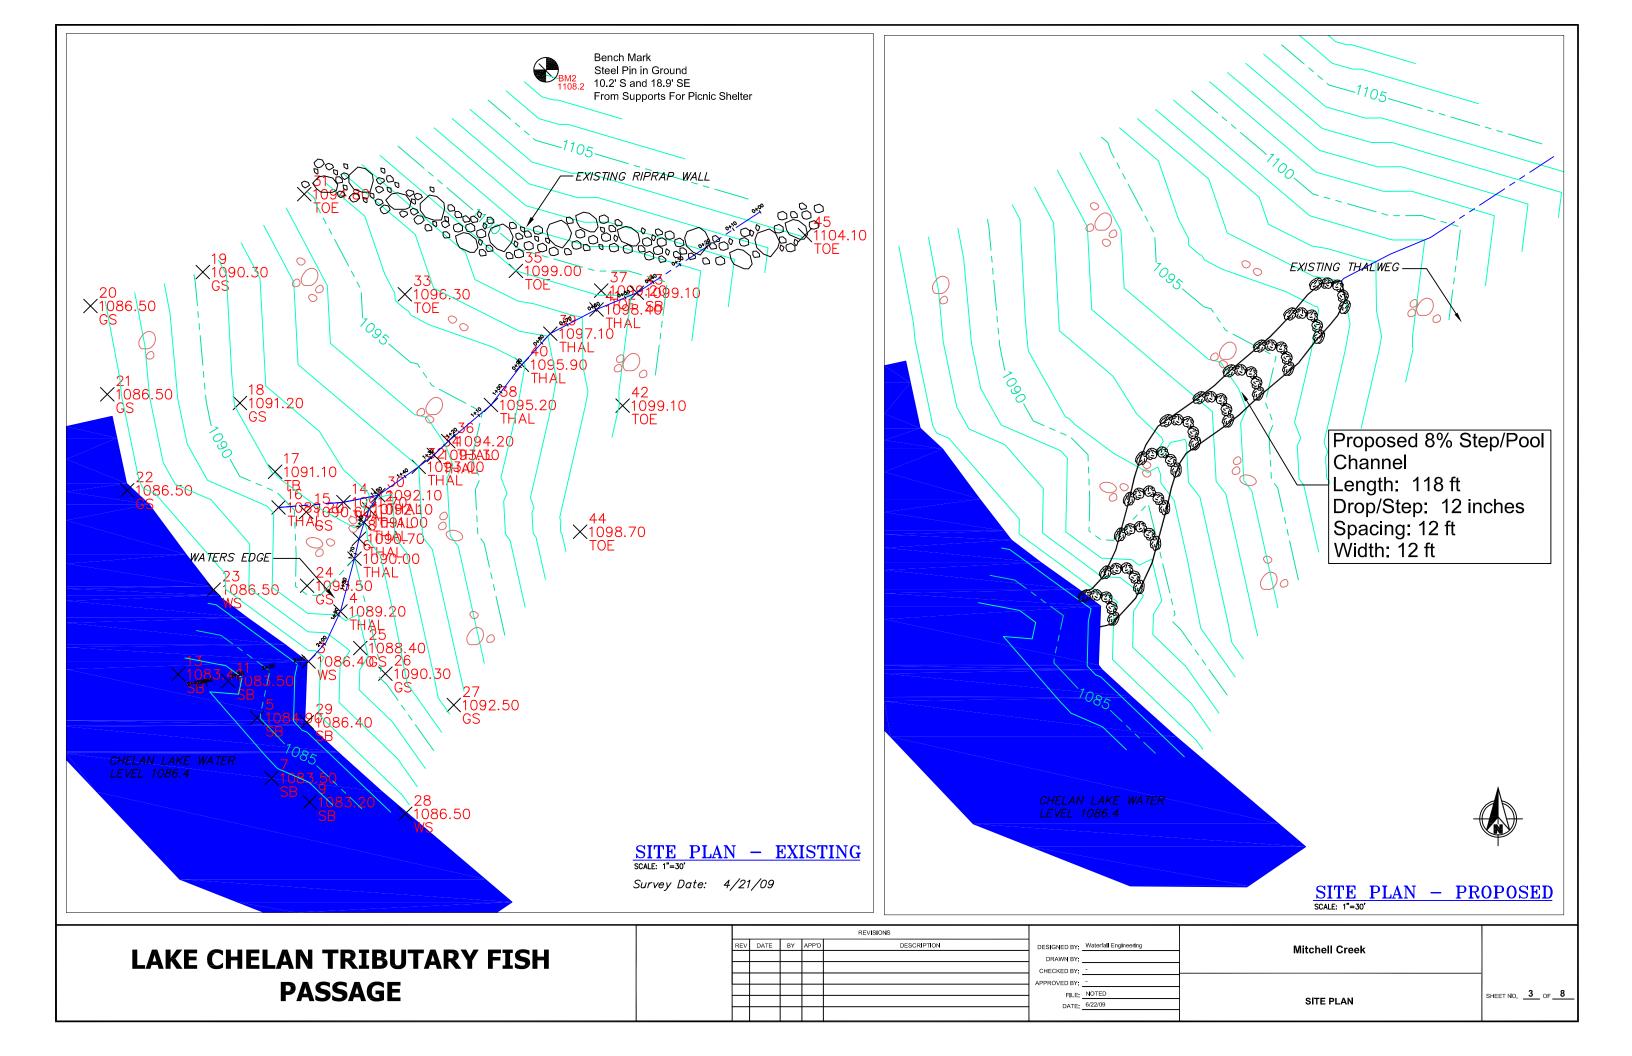


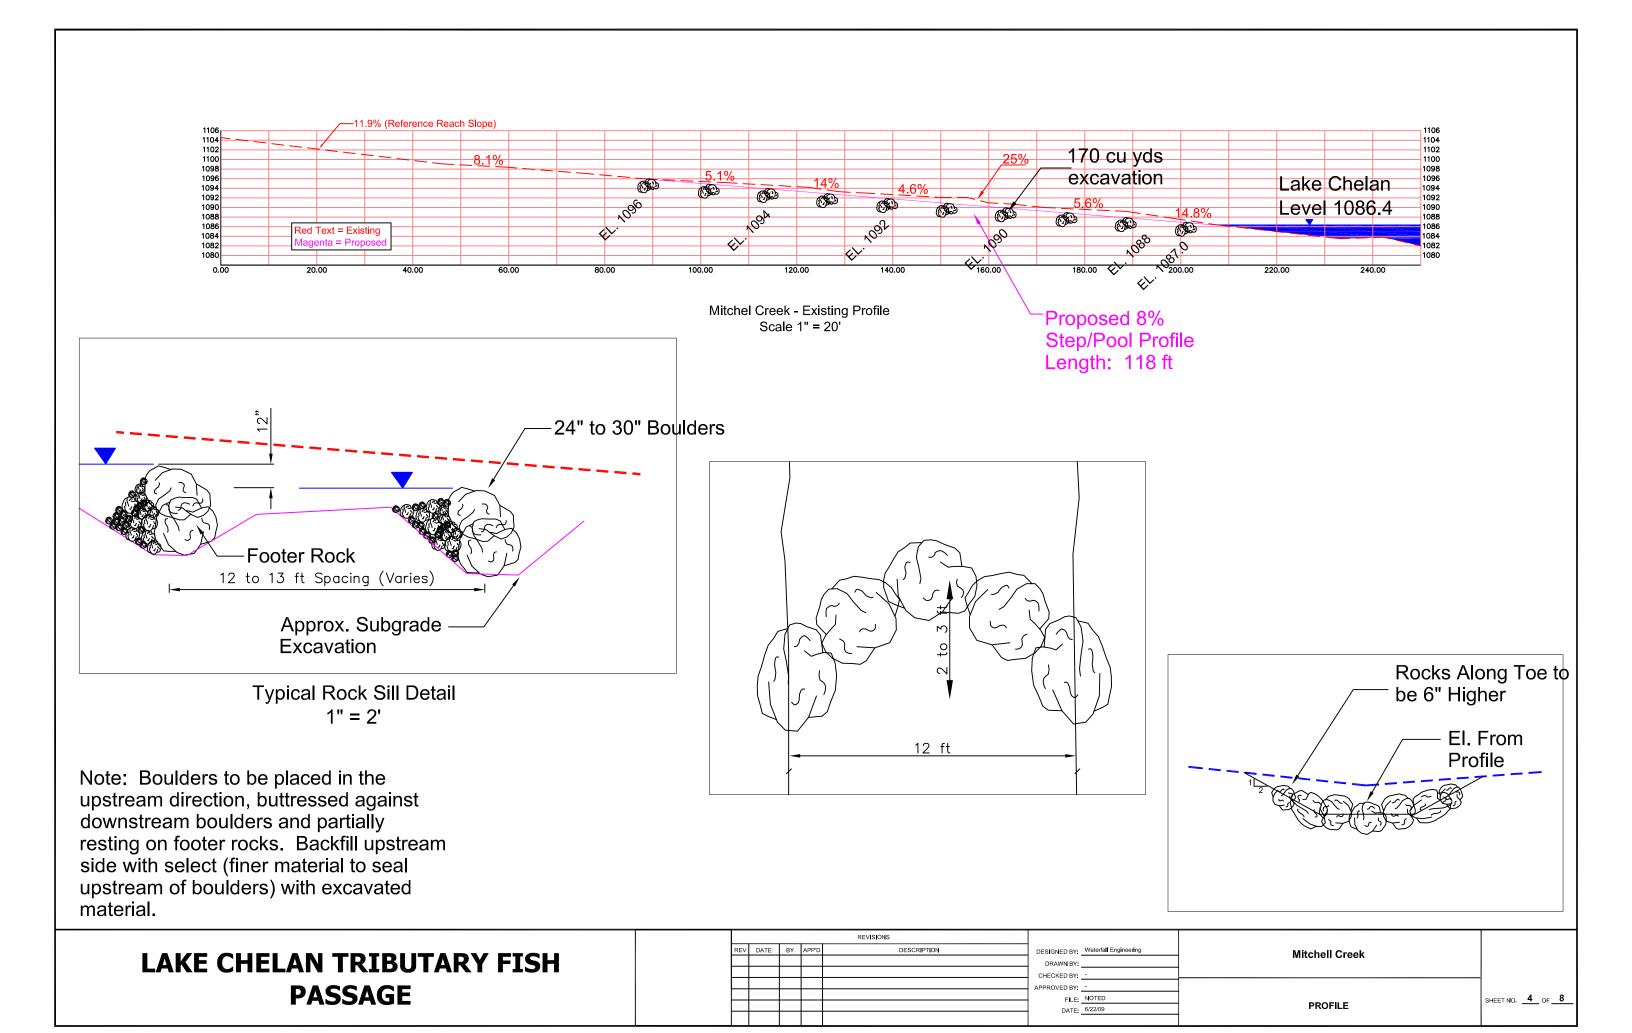


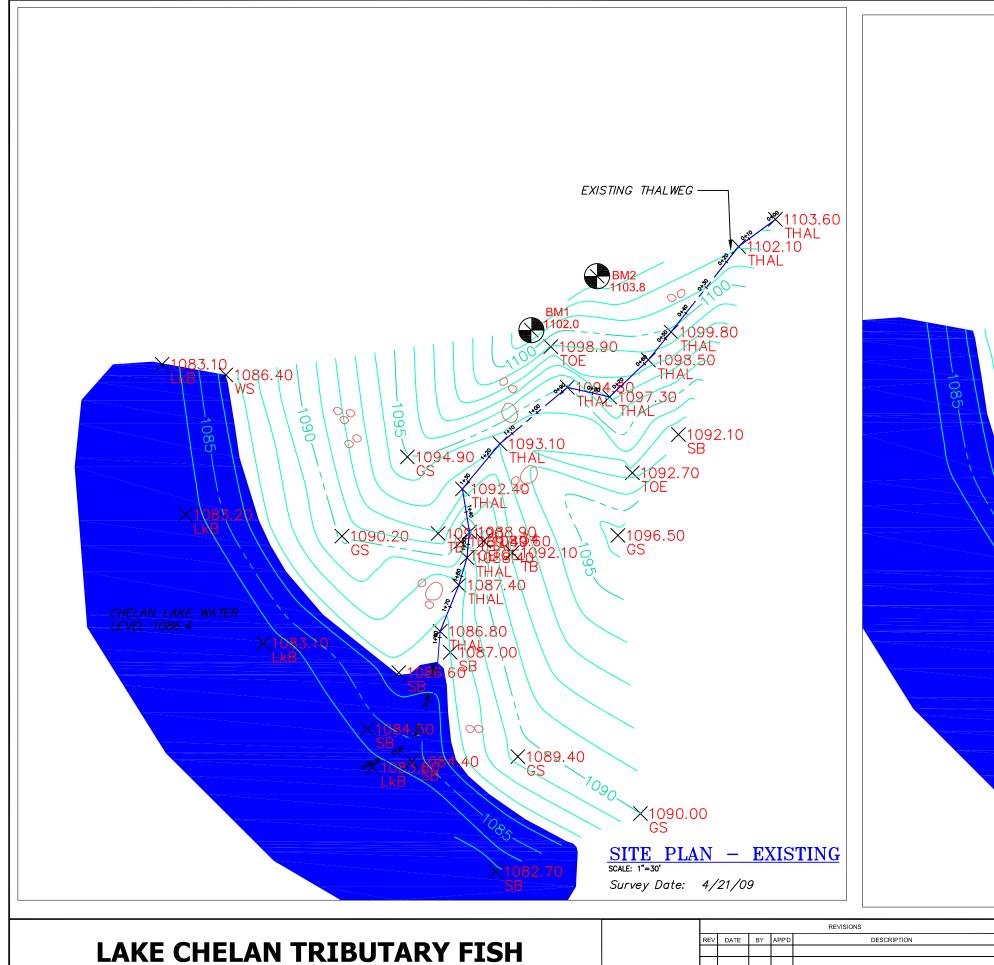

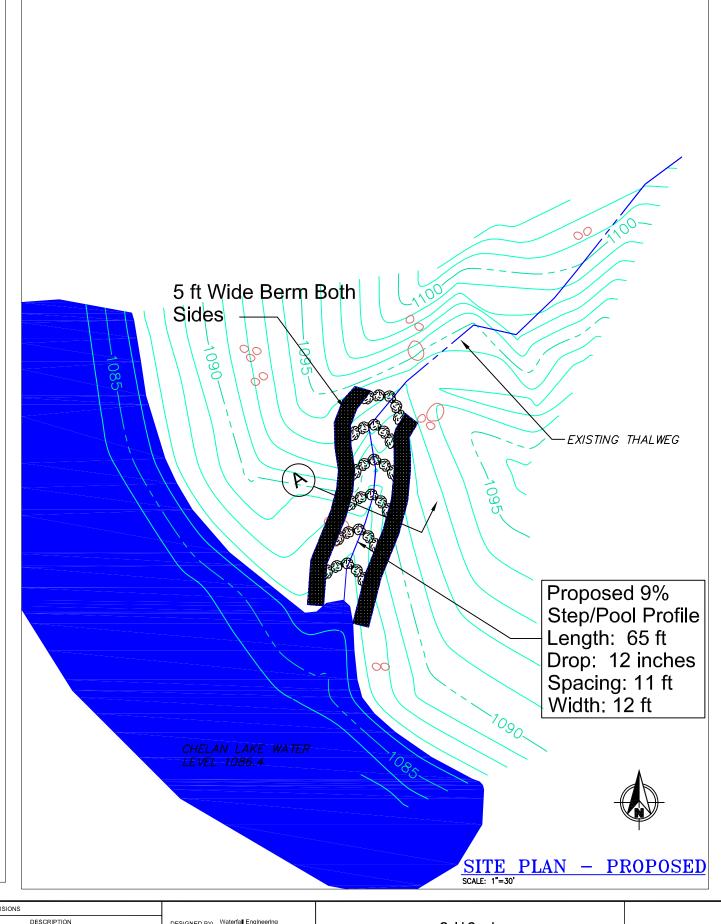

T		REVISIONS							
	REV	DATE	BY	APP'D	DESCRIPTION	DESIGNED BY: Waterfa∎ Engineering	Gold Creek		
L						DRAWN BY:	Gold Greek		
L						CHECKED BY: -			
L						APPROVED BY: -			
ļ						FILE: NOTED		SHEET NO. 5 OF	
ļ						DATE: 6/22/9	SITE PLAN		
-]		

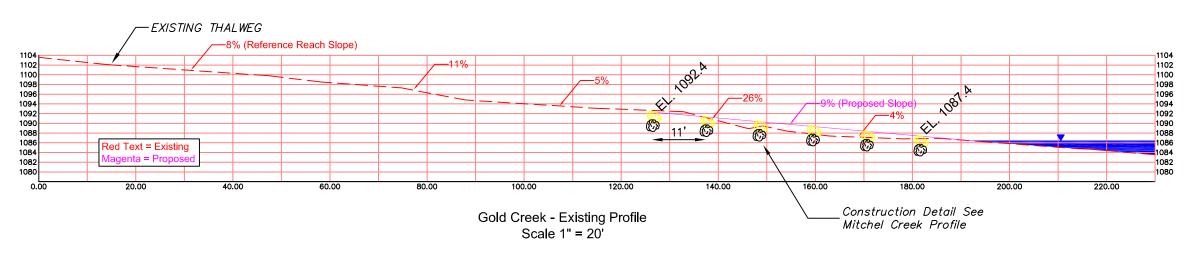

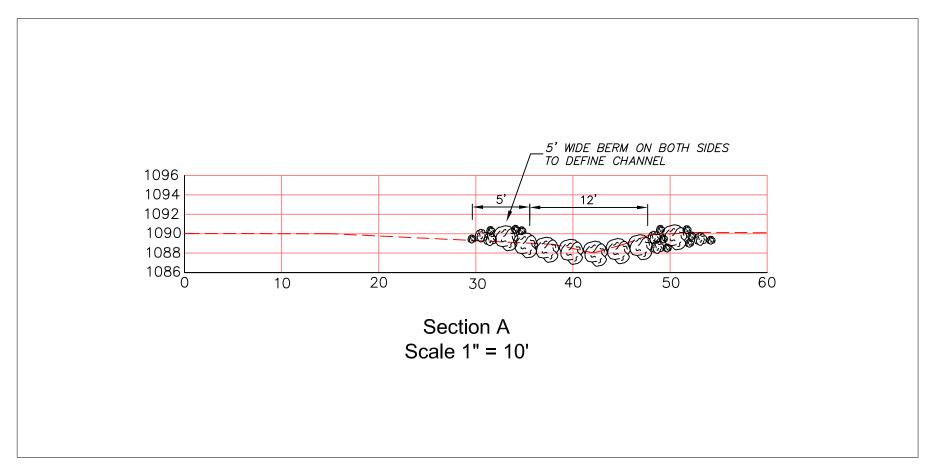



LAKE CHELAN TRIBUTARY FISH PASSAGE

				TLE TIGOTO			1
REV	DATE	BY	APP'D	DESCRIPTION	DESIGNED BY:	Waterfa I Engineering	
					DRAWN BY:]
					CHECKED BY:	•	L
					APPROVED BY:	-	1
					FILE:	NOTED	1
					DATE:	6/22/9	1
							1

Gold Creek

PROFILES SHEET NO. 6 OF 8

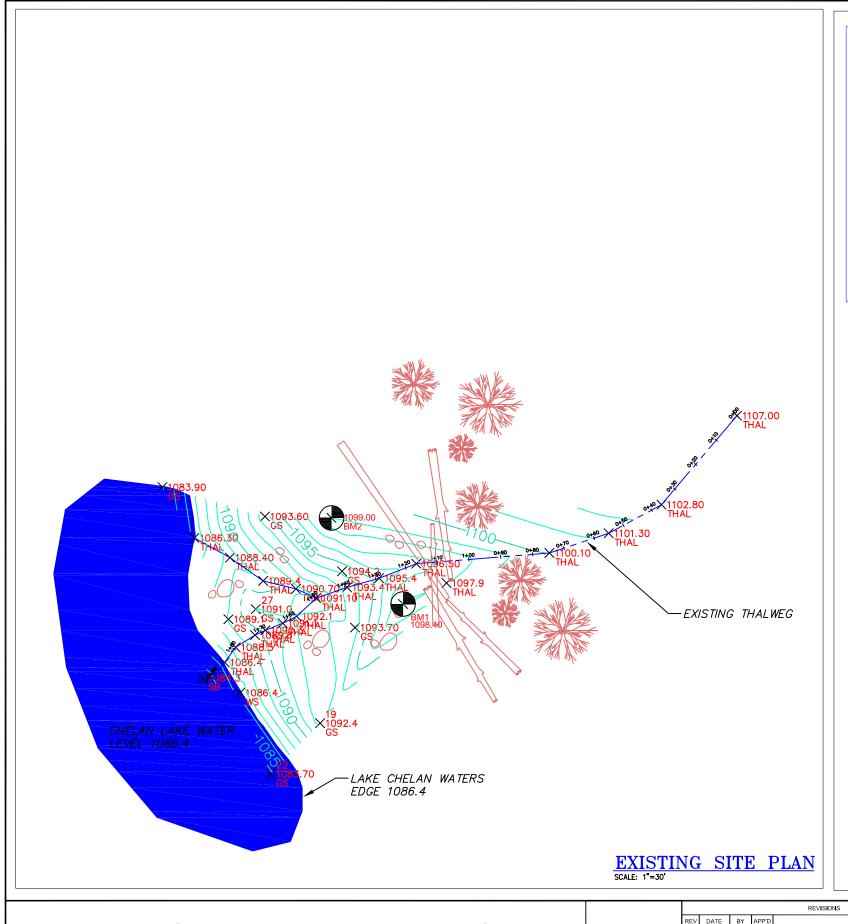

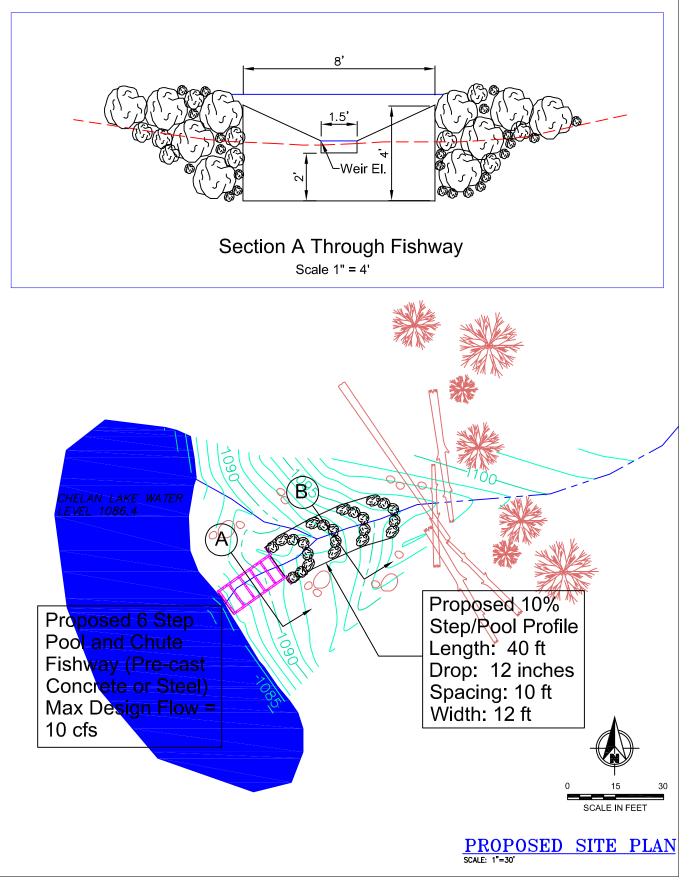


GRADE CREEK


SITE PLAN

SHEET NO. 7 OF 8


				REVISIONS		
REV	DATE	BY	APP'D	DESCRIPTION	DESIGNED BY:	Waterfall Engineering
					DRAWN BY:	
					CHECKED BY:	-
					APPROVED BY:	-
					FILE:	NOTED
_					DATE:	6/22/9
1		l				

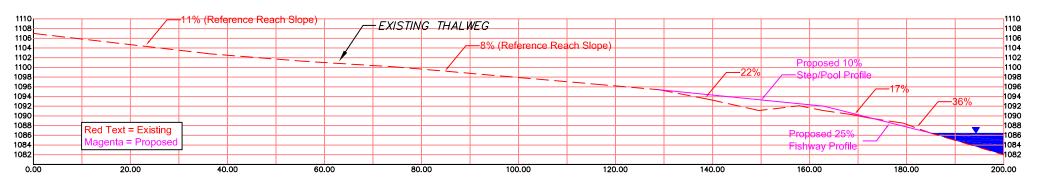

Grade Creek - Existing Profile Scale 1" = 20'

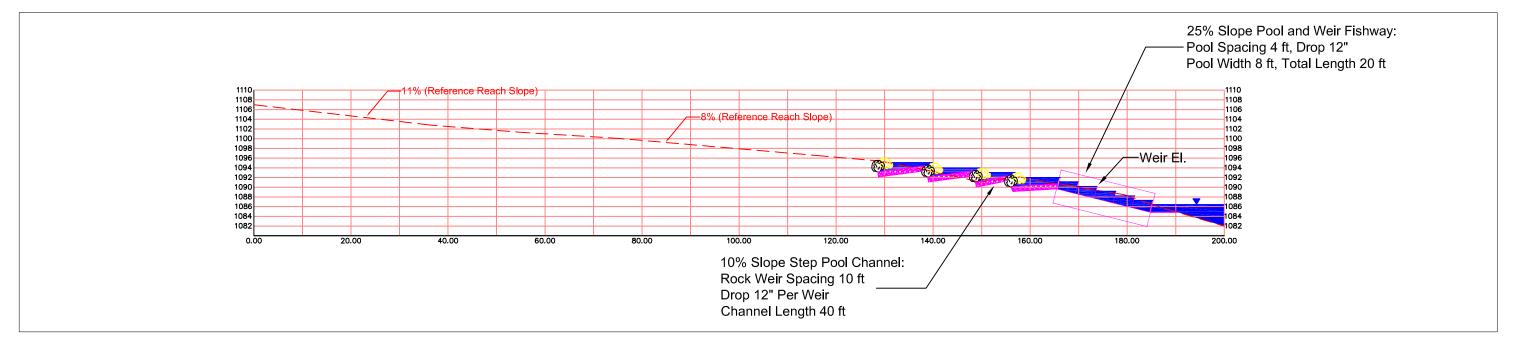

Grade Creek - Proposed Profile Scale 1" = 20'

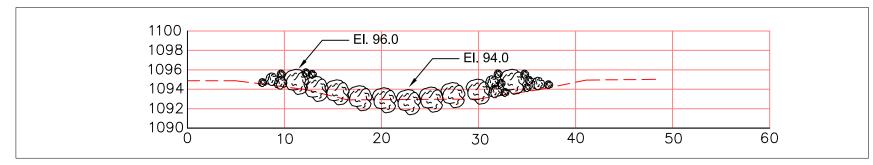

Section B Scale 1" = 10'

				REVISIONS			
REV	DATE	BY	APP'D	DESCRIPTION	DESIGNED BY: Waterfa∎ Englneering	Grade Creek	
					DRAWN BY:	Grade Greek	
					CHECKED BY:		_
					APPROVED BY:		
		-			FILE: NOTED	Profiles	SHEET NO. 8 OF
\rightarrow					DATE: 6/22/9	1.011100	